

EXISTING VIEW RIGHT SIDE FROM REAR



EXISTING VIEW LEFT SIDE



EXISTING VIEW RIGHT SIDE



EXISTING VIEW FRONT

28 JULY 2019

ISSUED FOR SPECIAL PERMIT

PROJECT

PROPOSED DORMER ADDITIONS 29 CEDAR STREET SOMERVILLE, MA

ARCHITECT:

GCD ARCHITECTS

2 Worthington St Cambridge, MA 02138 Tel. 617-412-8450 ajglassman.ra@gmail.com www.glassmanchungdesign.com



DRAWING LIST:

ZONING PLANS
PROPOSED LANDSCAPE PLAN
EXISTING FLOOR PLANS
EXISTING ELEVATIONS
PROPOSED FLOOR PLANS

A1.1 PROPOSED FLOOR PLANS
A1.2 PROPOSED ROOF PLAN AND SECTION

A2.1 PROPOSED ELEVATIONS

I CERTIFY THAT THIS PLAN WAS MADE FROM AN INSTRUMENT SURVEY ON THE GROUND BETWEEN THE DATES OF MAY 19, 2017 - JUNE 18, 2019 AND ALL STRUCTURES ARE LOCATED AS SHOWN

ACCORDING TO THE FEDERAL EMERGENCY MANAGEMENT AGENCY (F.E.M.A.) MAPS, THE MAJOR IMPROVEMENTS ON THIS PROPERTY FALL IN AN AREA DESIGNATED AS


COMMUNITY PANEL: 25017C0438E 06-04-2010 EFFECTIVE DATE:

CERTIFIED PLOT PLAN

LOCATED AT 27-29 CEDAR STREET SOMERVILLE, MA

SCALE: 1.0 INCH = 10.0 FEET



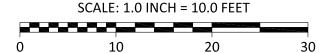

PREPARED FOR:

CHARLES SPELLMAN 27-29 CEDAR STREET, UNIT 29 SOMERVILLE, MA 02143

REFERENCES:

OWNER OF RECORD: 27-29 CEDAR STREET CONDOMIIUM 27-29 CEDAR STREET SOMERVILLE, MA 02143

MASTER DEED: BK 69594; PG 378 BK 69694: PG 454 UNIT DEED: PLANS: PL BK 22; PL 47 PL BK 28; PL 38

PL BK 256; PL 10 PL 1988 #965 PL 2007 #1358 PL 2017 #631

NOTES:

ZONING DISTRICT:

LOT SIZE

AREA, DW/UNIT

LANDSCAPED

HEIGHT, FEET

SIDE SETBACK

REAR SETBACK

PERVIOUS AREA

FRONTAGE

(MIN.)

(MIN.)

(MIN.)

20.0'

50.0'

35%

HEIGHT, STORIES

FRONT SETBACK


GROUND COVERAGE

17.4'*

44.00"

54.9%

PARCEL ID: 36-A-55-29 VERTICAL DATUM: ASSUMED AVERAGE GRADE: 501.1 (CALC.)

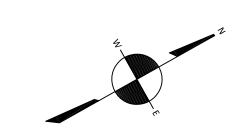

DH FND


DH FND

CEDAR STREET


(40' WIDE ~ PUBLIC)


N29°23'00"E

DH FND

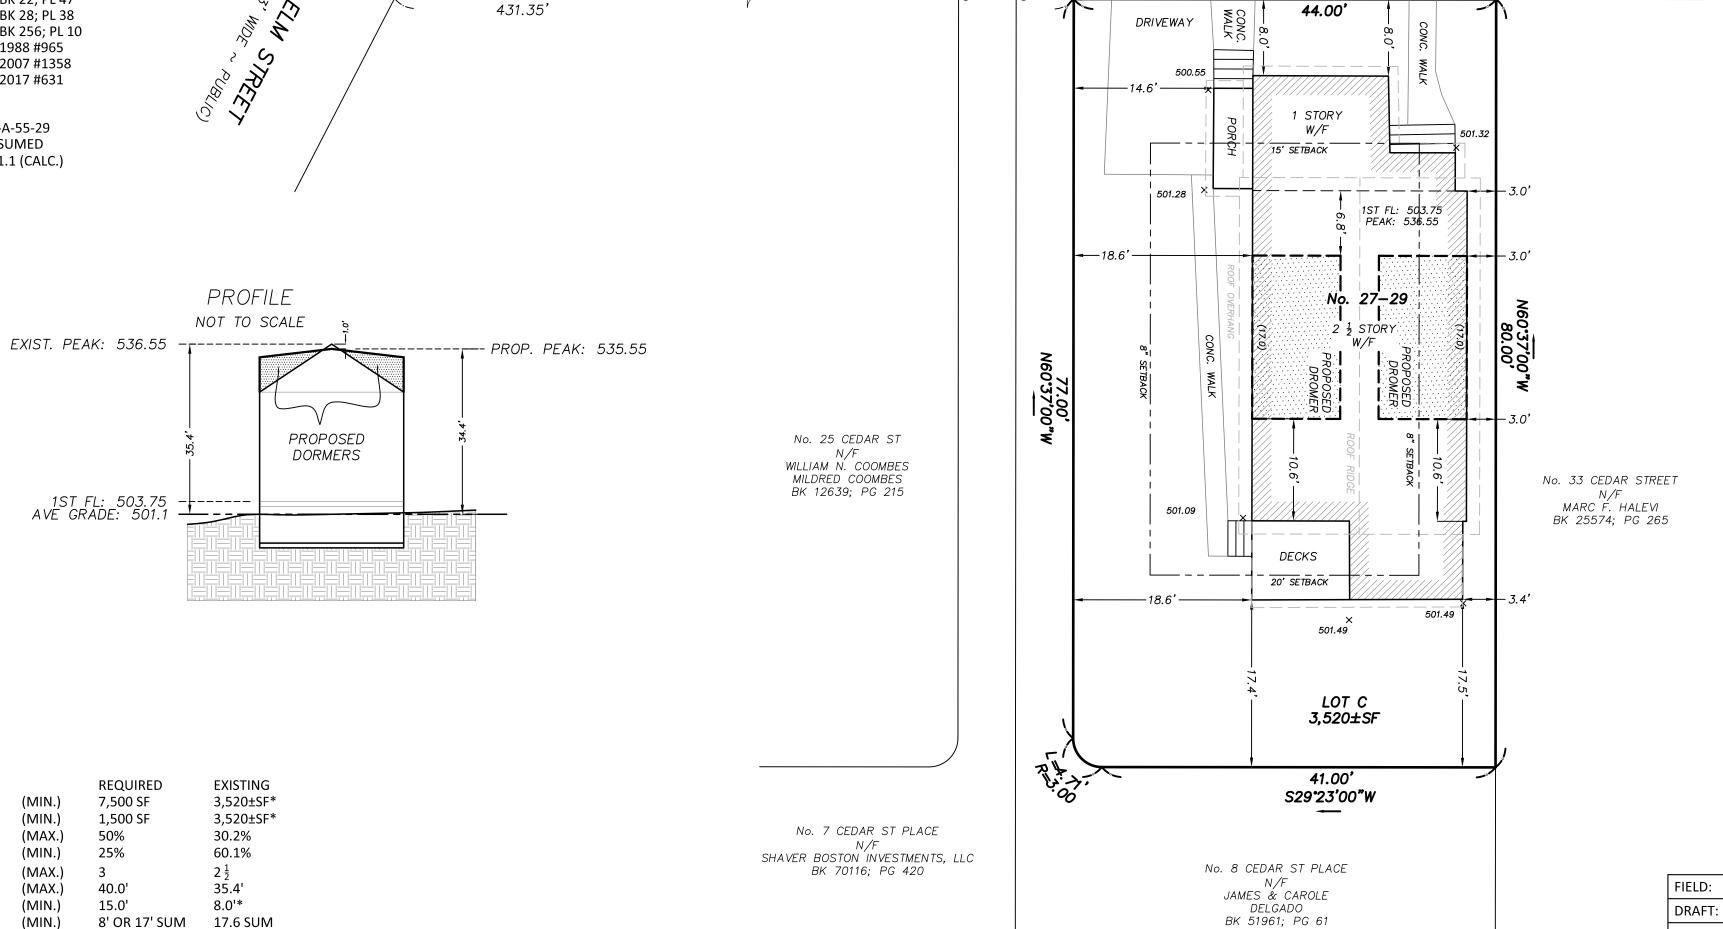

N29°23'00"E

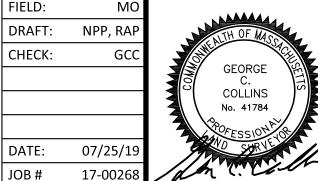

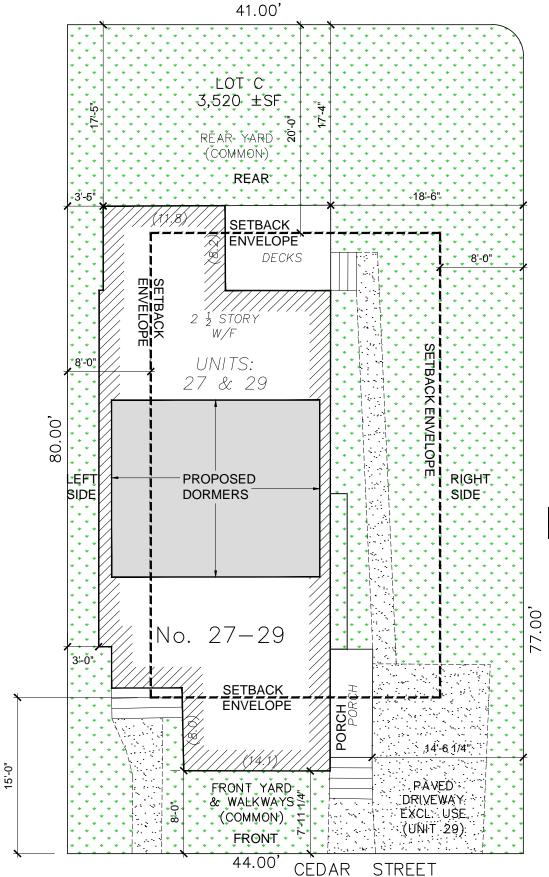

EXISTING SITE PLAN WITH PROPOSED DORMERS SCALE : $\frac{1}{4}$ " = 1'-0"

ZONING SUMMARY Zoning District: RB (Residential B) DESCRIPTION CODE REFERENCE PROPOSED REQUIRED/ALLOWED GENERAL RESIDENTIAL USE--TWO-FAMILY DWELLING ALLOWED ALLOWED 3,520.0 SF NO CHANGE NET FLOOR AREA (PER ZONING DEF'N) 4,239 SF 3,520.0 NSF 0.67 0.89 CONFORMS MIN. LOT AREA PER DWELLING UNIT NO CHANGE CONFORMS 1,500 SF 1,760 SF NO CHANGE CONFORMS MAX GROUND COVERAGE 30.2% OF LOT §8.5 50% OF LOT 60% OF LOT NO CHANGE CONFORMS LANDSCAPED AREA, MIN §8.5 §8.5 55% OF LOT NO CHANGE CONFORMS 35% OF LOT §8.5 40', 3 STOREYS 35.4', 2.5 STORIES MIN. FRONT YARD §8.5 SUM OF 16 MIN. SIDE YARD 8'-0" OR SUM OF 16'-0" LEFT SIDE NON-CONFORMING ADDITION §8.5

2 SPACES PER (3) BEDROOM UNIT

17.25'

NO CHANGE / CONFORMING ADDITION

NO CHANGE / CONFORMING
REQUIREMENT DOES NOT CHANGE

PROJECT:

Dormer Additions
29 Cedar St
Somerville, MA

GCD ARCHITECTS

2 Wormington St Cambridge, MA 02138 Tel. 617-412-8450 ajglassman@hotmail.com www.glassmanchungdesign.c



ISSUED FOR ZBA SPECIAL PERMIT


EXISTING LANDSCAPE 2,115.5 SF / 3,520.0 SF LOT = .60

§8.5

§8.5

MIN. REAR YARD


MIN. FRONTAGE

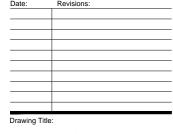


ZONING PLAN


Scale: AS NOTED Drawing No. :

Job No.: A134.00
Date: 28 JULY 2019

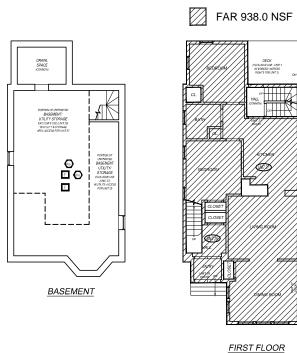

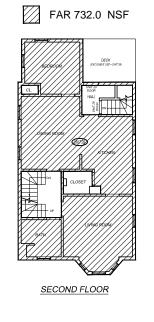



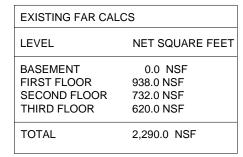

EXISTING FAR 2,290.0 / 3,520 SF LOT = .65 FAR EXISTING CONFORMING

PROPOSED FAR CALCS	
LEVEL	NET SQUARE FEET
BASEMENT FIRST FLOOR SECOND FLOOR THIRD FLOOR	0.0 NSF 938.0 NSF 732.0 NSF 547.0 NSF
TOTAL	2,217.0 NSF


PROPOSED FAR 2,217.0 / 3,520 SF LOT = .62 FAR EXISTING CONFORMING

GCD ARCHITECTS


2 Worthington St Cambridge, MA 02138 Tel. 617-412-8450 ajglassman@hotmail.com www.glassmanchungdesign.cu





ISSUED FOR ZBA SPECIAL PERMIT

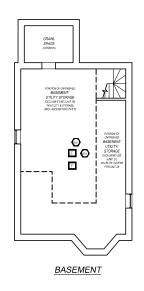



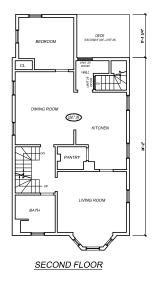

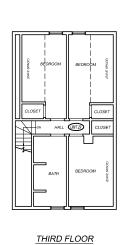

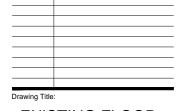

EXISTING FLOOR PLANS & FAR CALCS


Scale: AS NOTED Drawing No. :

Job No.: A134.00
Date: 28 JULY 2019


Date: 1 D 1 1

AL HOW DOMEN MAD TO HAVE CLASTO COLL STATE HOME HALLMAN, 19-15



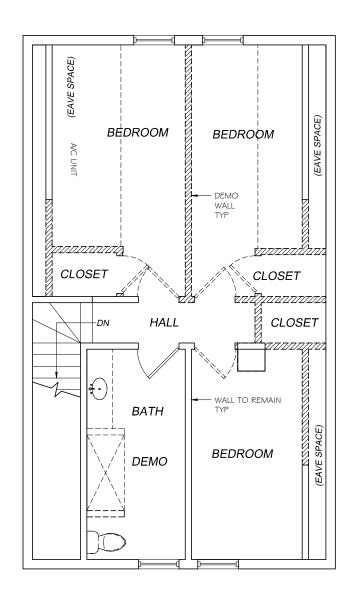

THIRD FLOOR EXISTING

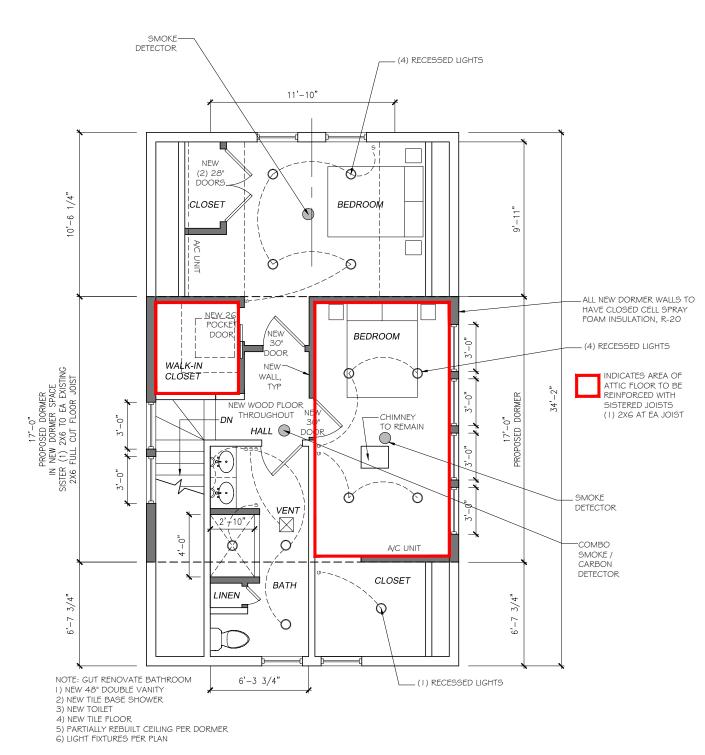

THIRD FLOOR PROPOSED



GCD ARCHITECTS

2 Worthington St Cambridge, MA 02138 Tel. 617-412-8450 ajglassman@hotmail.com www.glassmanchungdesign.

ISSUED FOR ZBA SPECIAL PERMIT

DOUBLE DORMER FINISH SHELL

- * DEMO THE INTERIOR PLASTER AND INSULATION IN THE AREA OF THE PROPOSED DORMERS, KEEP ALL BATHROOM WALLS INTACT.
- * REMOVE TWO 17' SECTIONS OF MAIN ROOF TO ADD SHEI DORMERS.
- * BUILD END AT 7-0" HEIGHT PLUS OR MINUS . FRAME WALLS WITH 2X6 WALL FRAMING AND ½" EXTERIOR PLYWOOD. * FRAME THE ROOF WITH 2X10 RAFTERS 16" ON CENTER AND 5%" ROOF PLYWOOD.
- * INSTALL FASCIA AND RAKE BOARDS IN PRIMED PINE
- * PAPER THE DORMER SHELL WITH TYVEK OR EQUAL QUALITY HOUSE WRAP.
- * INSTALL (6) WINDOWS TOTAL (4) 36" X 36" NOMINAL AWNING (2) 36" X 36" NOMINAL FIXED
- * INSTALL PRIMED CEDAR SHINGLE SIDING TO MATCH TH EXISTING HOUSE SIDING EXPOSURE AS CLOSE AS POSSIB
- * INSTALL A 30 YEAR ASPHALT ROOF SHINGLE ON THE DORMERS TO MATCH THE EXISTING ROOF.
- * FRAME INTERIOR WALLS FOR 1 BEDROOMS AN OFFICE NOOK AREA AND A WALK-IN CLOSET.
- * INSTALL A ONE PIECE ALUMINUM GUTTER AN
- DOWNSPOUT/S ON THE NEW DORMERS.
- $^{\circ}$ REMOVE ALL BUILDING DEBRIS GENERATED BY HIGH TECH DORMER CORP.
- * PROVIDE A BUILDING PERMIT FOR THE DORMER SHELL

Date:	Revisions:
Drawing Title	e:

EXISTING ATTIC & PROPOSED DORMER PLANS

Scale: AS NOTED Drawing No. :

Job No.: A134.00

Date: 28 JULY 2019

SCALE: $\frac{3}{8}$ " = 1'-0"

DIMENSION LUMBER SHALL BE STRESS RATED, 19% MAX. M.C., WITH THE FOLLOWING GRADES AND PROPERTIES. JOISTS AND PLANKS - HEM FIR #2 Fb = 1000 PSI, Fv = 75 PSI, E = 1,4000,000 PSI PROJECT:

Dormer Additions
29 Cedar St
Somerville, MA 22'-6 1/2" PROPOSED DORMER SPACE STUDS - HEM FIR, STUD Fc = 500 PSI, Fv = 75 PSI, E = 1,200,000 PSI OVERFRAME FALIX GABLE RIDGE TO 2X | 2 RIDGE BEAM — BEAMS AND STRINGERS, DOUGLAS FIR-LARCH #1 MATCH EXISTING Fb = 1,350 PSI, Fv = 85 PSI, E = 1,600,000 PSIHP ROOF POSTS AND TIMBERS, DOUGLAS FIR-LARCH #1 3.5 - 2X | 2 RAFTERS OVERFRAME 2X10 -RAFTERS @ 16" O.C. $Fb = 1,200 \text{ PSI}, \quad Fc = 1,000 \text{ PSI}, \quad E = 1,600,000 \text{ PSI}$ @ 12" O.C. DORMER ROOF GCD ARCHITECTS R-49 -HEADER: (2) 2X10 -DOUBLE JACK, KING JAMBS, TYP EXISTING GABLE EXISTING GABLE ROOF TO BE REMOVED ROOF TO BE REMOVED CONTINUE GABLE _ EAVE PAST THE STAIR BATHROOM BEDROOM DORMER WALLS, TYP FUTURE SOLAR FXISTING REMOVE WALL GABLE ROOF PANELS THIRD FLOOR FLOOR FRAMING: ISSUED FOR ZBA EXISTING STAIR SISTER (1) 2X6 TO TO REMAIN SPECIAL PERMIT EACH EXISTING 30X30 SKYLIGHT FULL CUT 2X6 @ 16" O.C., REFER TO PLAN FOR EXTENT 22'-6 1/2" PROPOSED SHED DORMERS SECOND FLOOR FUTURE SOLAR PANELS UNIT 1 FIRST FLOOR EXISTING GABLE ROOF UNFINISHED BASEMENT PROPOSED DORMER BASEMENT **ROOF PLAN AND DORMER SECTION** PROPOSED DORMER PROPOSED DORMER **ROOF PLAN** Drawing No. **SECTION** A134.00 SCALE: $\frac{3}{8}$ " = 1'-0" Date: 28 JULY 2019

STRUCTURAL GENERAL NOTES:

